


WALL TYPE SCHEDULE

TAG	STUD SIZE	STUD O.C.	WALL HEIGHT	CYBRD THICKNESS	CYBRD LAYERS	FIRE RATING	CAVITY BATT INSULATION	REMARKS
A1	2 1/2"	16"	PARTIAL HGT	5/8"	1 EA. SIDE	NA		
A2	2 1/2"	16"	UNDERSIDE CLG	5/8"	1 EA. SIDE	NA		
A3	2 1/2"	16"	6" ABOVE CLG	5/8"	1 EA. SIDE	NA		
A4	2 1/2"	16"	DECK	5/8"	1 EA. SIDE	NA	2"	
B1	3 1/2"	16"	PARTIAL HGT	5/8"	1 EA. SIDE	NA		
B2	3 1/2"	16"	UNDERSIDE CLG	5/8"	1 EA. SIDE	NA	3 1/2"	
B3	3 1/2"	16"	6" ABOVE CLG	5/8"	1 EA. SIDE	NA	3 1/2"	
B4	3 1/2"	16"	DECK	5/8"	1 EA. SIDE	NA	3 1/2"	
C1	5 1/2"	16"	PARTIAL HGT	5/8"	1 EA. SIDE	NA		
C2	5 1/2"	16"	UNDERSIDE CLG	5/8"	1 EA. SIDE	NA		
C3	5 1/2"	16"	6" ABOVE CLG	5/8"	1 EA. SIDE	NA	5 1/2"	
C4	5 1/2"	16"	DECK	5/8"	1 EA. SIDE	NA	5 1/2"	
R1	6 3/8"		EXTERIOR		1 SIDE		E.P.S.	R-CONTROL PANEL

NOTE:

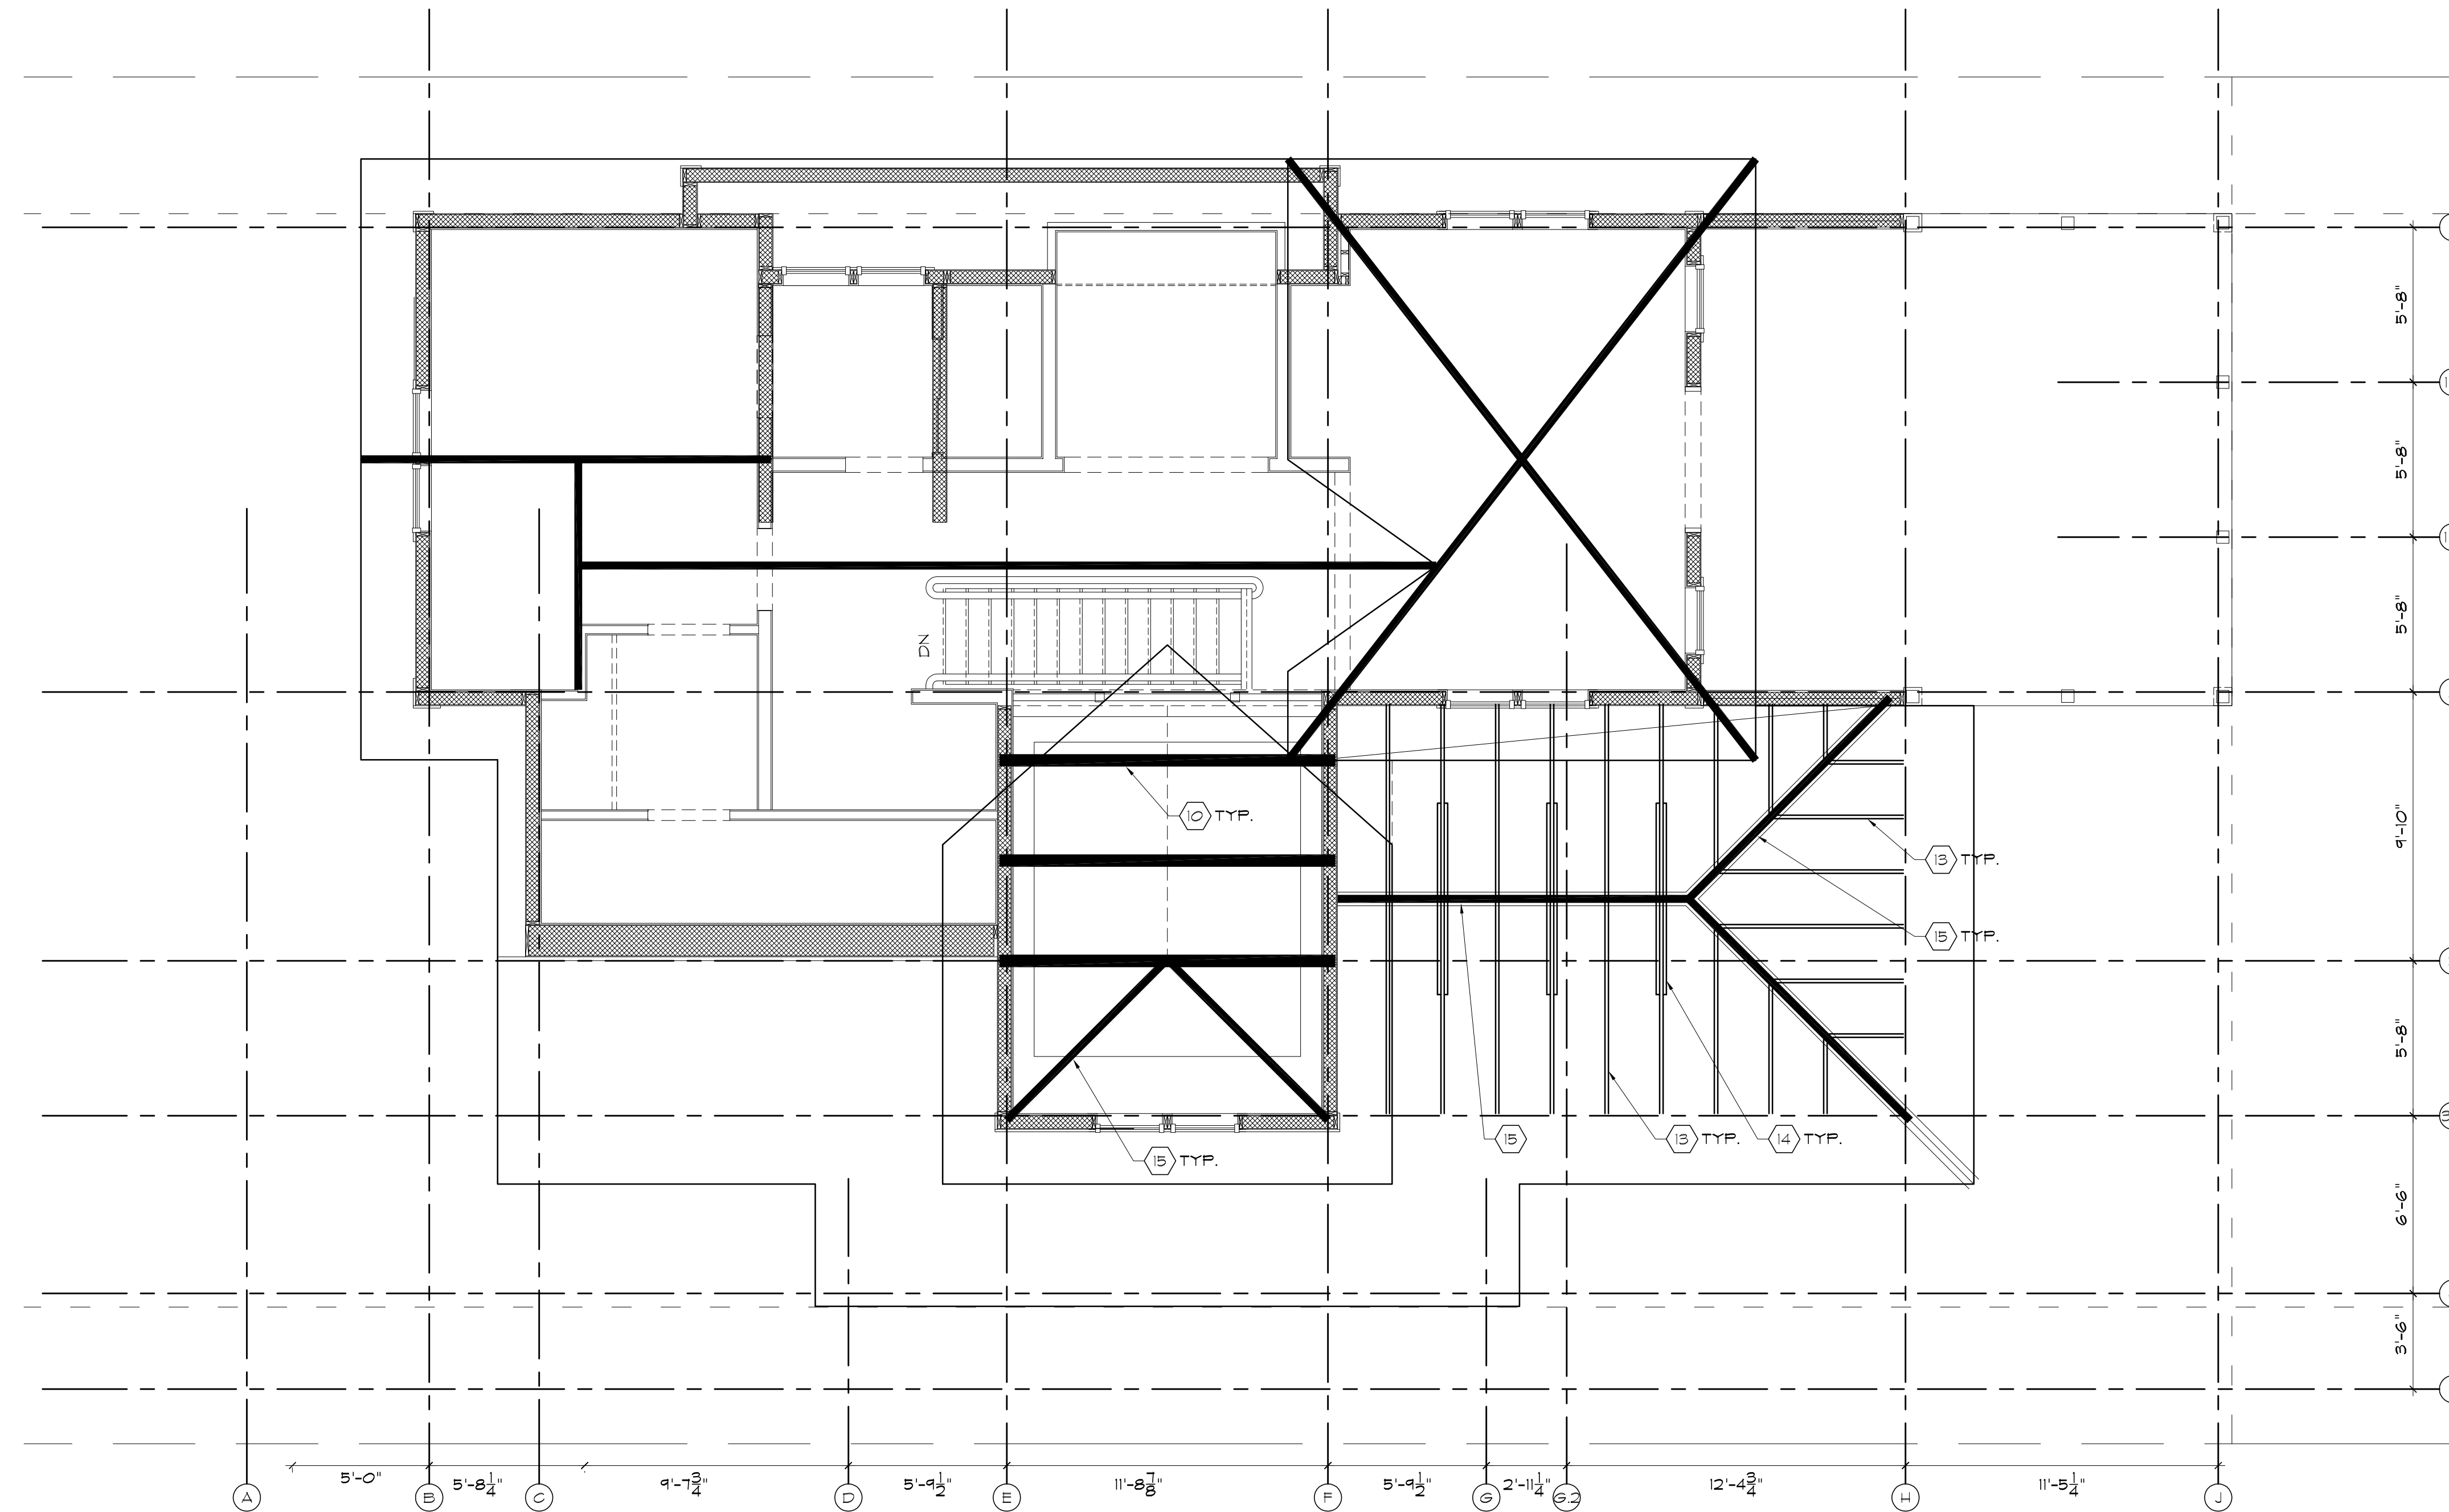


PLAN NOTES:


- (1) 12" D OPEN WEB WOOD TRUSSES AT 24" O.C.
- (2) TREATED #1 SOUTHERN PINE 2X12 @ 16" O.C.
- (3) 3 LVL, 11-7/8" DEEP
- (4) 2 LVL, 11-7/8" DEEP
- (5) MIN. BEARING LENGTH 5" ON 3 STUDS
- (6) MIN BEARING LENGTH 3"
- (7) 1-1/4" X 11-7/8" TIMBERSTRAND LSL RIM BOARD OR EQUIVALENT
- (8) 10X10 TIMBER POST OR EQUIVALENT
- (9) DOUBLE WOOD TRUSS
- (10) STRUCTURAL TIMBER TRUSS
- (11) TRELLIS, TREATED 2X8 #1 SOUTHERN PINE.
- (12) 3 1/2" LVL, 16" DEEP
- (13) 2x6 RAFTER
- (14) DOUBLE 2x6 COLLAR TIE
- (15) 4x8 BEAM
- (16) 12" D OPEN WEB WOOD TRUSSES AT 12" O.C.
- (17) 8x8 TIMBER POST OR EQUIVALENT.
- (18) 6x6 TIMBER RAILING POST OR EQUIVALENT.

ROOF FRAMING PLAN

SCALE: 1/4"=1'-0"

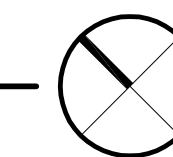

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CHANGED PANEL LOCATION
 ROOF FRAMING PLAN
 1 JUN 13
 CIN3401R

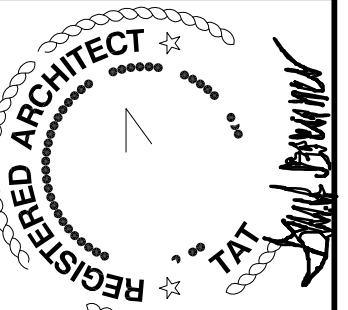SHEET NO.
SI.4