MEZZANINE FRAMING LAYOUT

-STEEL "C" RUNNER, BOLTED

TO UPPER DECK


-STEEL "C" RUNNER


■ ANCHOR BOLT, THROUGH SLAB

1, TYPICAL STEEL STUD WALL SECTION

SET IN EPOXY GROUT

SCALE: 3/16" = 1'-0"

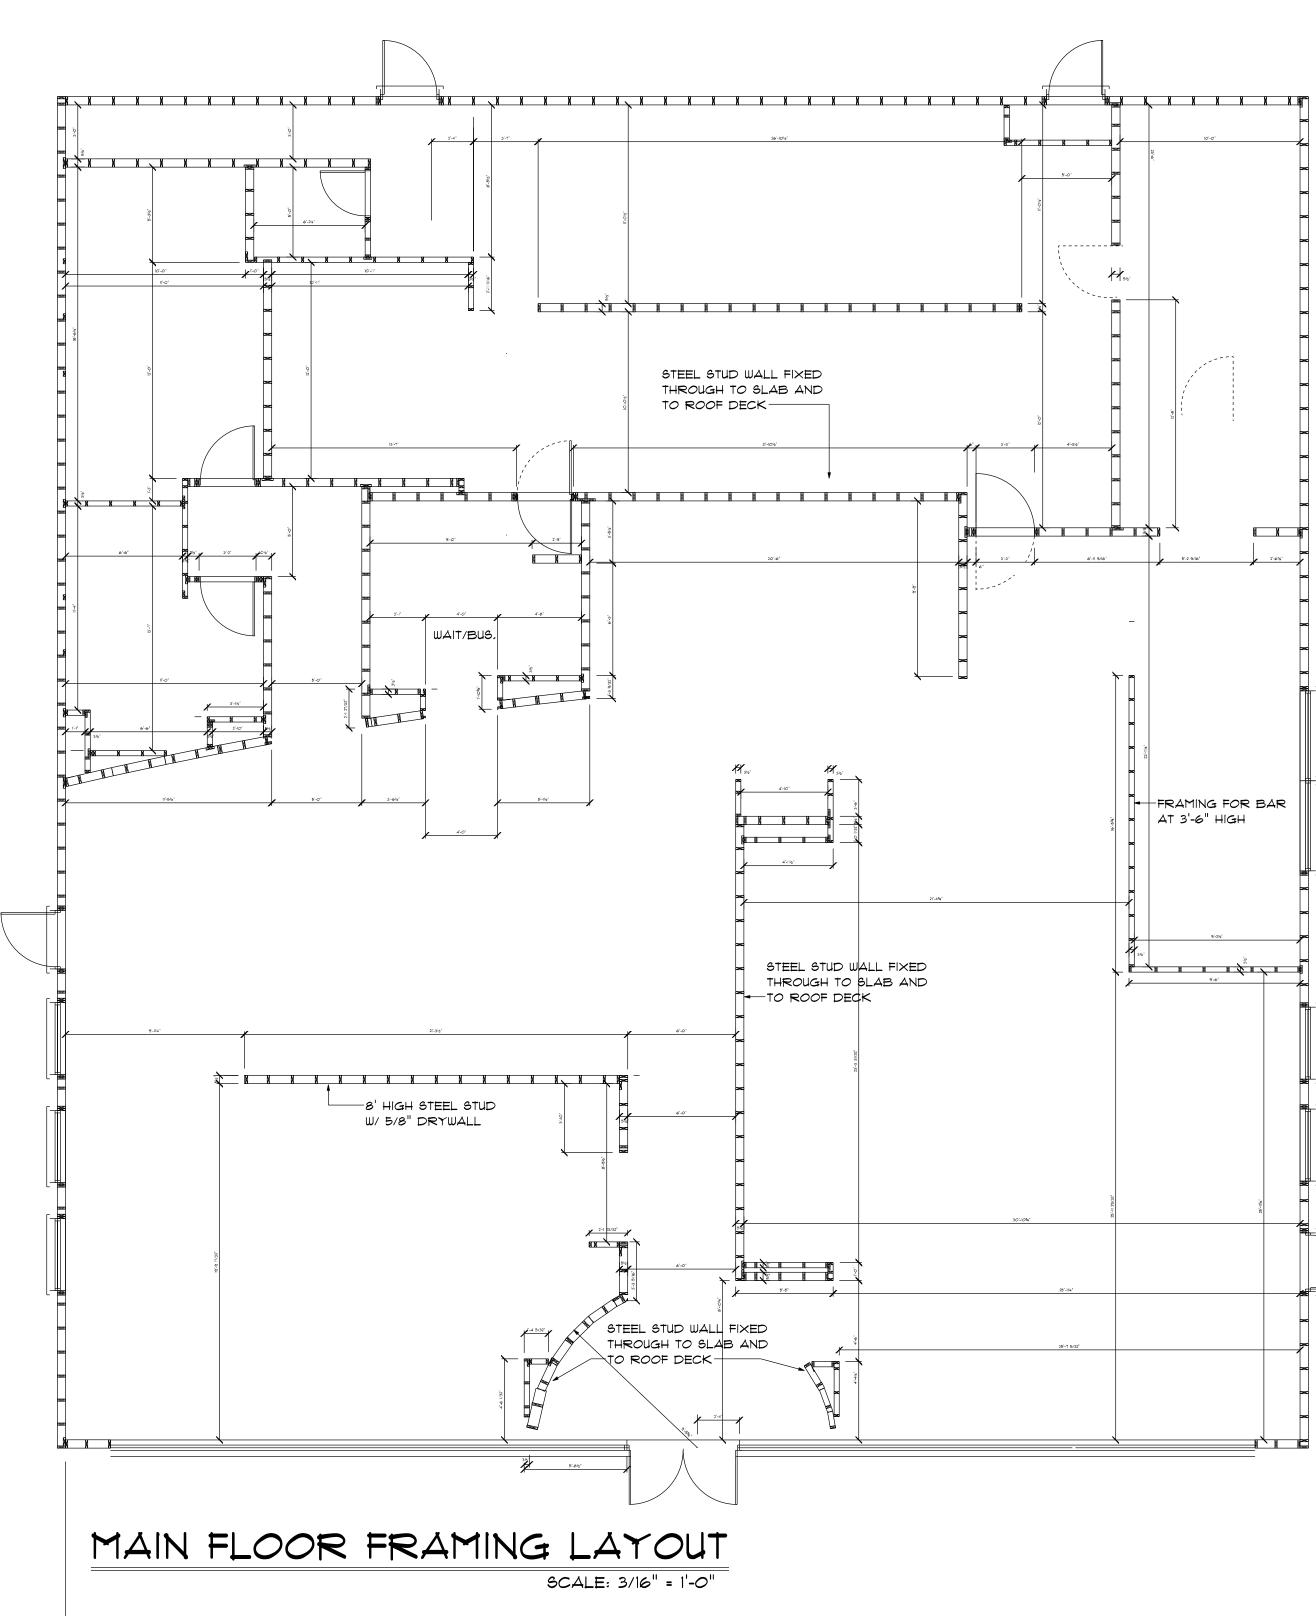

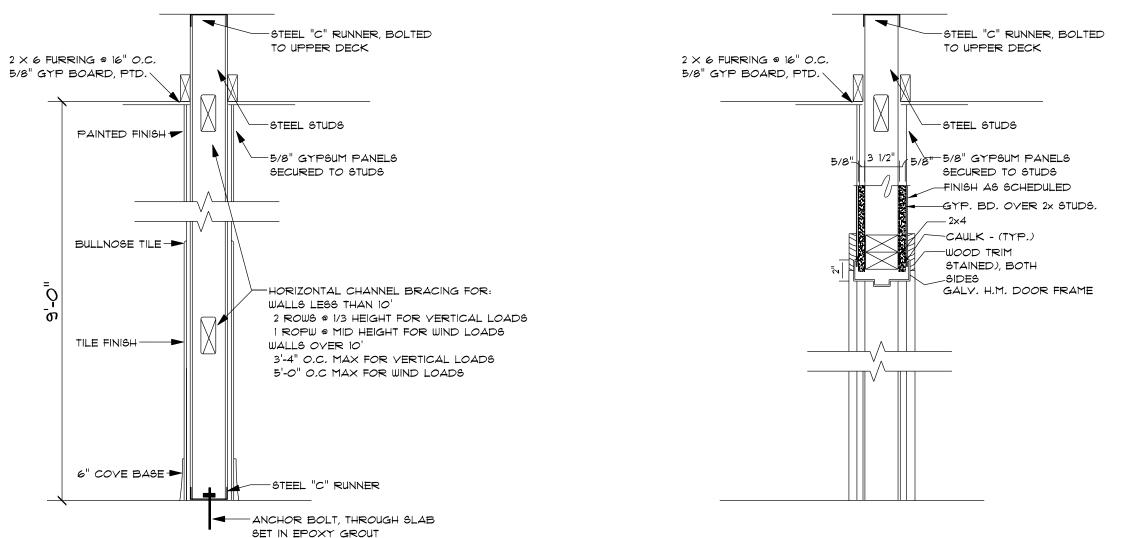

FIBREGLASS REINFORCE PANEL (F.R.P.) TO FULL HEIGHT OF WALL -STEEL STUDS 1/2" PLYWOOD SHEATHING -5/8" GYPSUM PANELS TO FULL HEIGHT OF WALL SECURED TO STUDS ----1/2" PLYWOOD SHEATHING

DROP CEILING ABOYE

KITCHEN AREA

-HORIZONTAL CHANNEL BRACING FOR: -HORIZONTAL CHANNEL BRACING FOR: WALLS LESS THAN 10' WALLS LESS THAN 10' 2 ROWS @ 1/3 HEIGHT FOR VERTICAL LOADS I ROPW @ MID HEIGHT FOR WIND LOADS 2 ROWS @ 1/3 HEIGHT FOR VERTICAL LOADS 1 ROPW @ MID HEIGHT FOR WIND LOADS WALLS OVER 10' WALLS OVER 10' 3'-4" O.C. MAX FOR VERTICAL LOADS 3'-4" O.C. MAX FOR VERTICAL LOADS 5'-0" O.C MAX FOR WIND LOADS 5'-0" O.C MAX FOR WIND LOADS - FIBREGLASS REINFORCE PANEL (F.R.P.) 1/2" PLYWOOD SHEATHING TO FULL HEIGHT OF WALL

FIBREGLASS REINFORCE PANEL (F.R.P.) TO FULL HEIGHT OF WALL-- 1/2" PLYWOOD SHEATHING -STEEL "C" RUNNER

2. TYPICAL KITCHEN STEEL STUD WALL SECTION

■ ANCHOR BOLT, THROUGH SLAB

SET IN EPOXY GROUT

-STEEL "C" RUNNER BOLTED A

TO UPPER DECK

3. TYPICAL RESTROOM STEEL STUD WALL SECTION

4. TYPICAL RESTROOM WALL SECTION THROUGH DOOR


WALL NOTES

- 3 5/8" 25 GA. METAL STUDS AT 16" O.C. WITH 5/8" TYPE 'X' GYP. BD. ON EACH SIDE FROM
- 3 5/8" 25 GA. METAL STUDS AT 16" O.C. TO ROOF DECK WITH 5/8" CEMENT BOARD FROM
- BOARD TO CEILING. SEE DETAIL 5/A106
- SIDE TO ROOF DECK ABOVE AND, ON THE RESTRM SIDE, 5/8" CEMENT BOARD FROM FLOOR TO 3'-0" A.F.F. AND 5/8" WATER RESISTANT TYPE 'X' GYP. BD. FROM 3'-0" A.F.F. TO CEILING. SOUND BATTS IN WALL CAVITY -FLOOR TO ROOF DECK AT RESTROOMS. SEE DETAIL 9/A106
- . 6" 25 GA. METAL STUDS AT 16" O.C. TO BOTTOM OF TRUSSES WITH CEMENT BOARD FROM FLOOR TO 6" ABOVE CEILING ON ONE SIDE AND 5/8" MARINE GRADE PLYWOOD ON THE OTHER
- . 3 5/8" METAL STUDS AT 16" O.C. FROM FLOOR TO ROOF DECK WITH 5/8" CEMENT BOARD
- . 6" 25 GA. METAL STUDS AT 16. O.C. FINISH INTERIOR FACE WITH 5/8" CEMENT BOARD FROM FLOOR TO 3'-0" A.F.F. AND 5/8" TYPE 'X' WATER RESISTANT GYP. BD. FROM 3'-0" A.F.F. TO 6"
- 3. 6" 25 GA. METAL STUDS AT 16" O.C. INTERIOR FACE WITH 5/8" TYPE 'X' GYP. BD. FROM FLOOR
-). LOW WALL 3 5/8" 25 GA. METAL STUDS AT 16" O.C. WITH 5/8" TYPE 'X' GYP. BD. ON EACH SIDE.
-). LOW WALL 3 5/8" 25 GA. METAL STUDS AT 16" O.C. WITH 5/8" TYPE 'X' GYP. BD. ON CUSTOMERSIDE AND 5/8" CEMENT BOARD FROM FLOOR TO 3'-0" A.F.F. AND 5/8" TYPE 'X' WATER RESISTANT GYP. BD. ABOVE.
- . 6" 25 GA METAL STUDS AT 16" O.C. FINISH INTERIOR FACE WITH 1 LAYER OF 5/8" TYPE 'X'
- 1A. 1-HR. RATED WALL: 3 5/8, 25 GA. METAL STUDS AT 16, O.C. TO STRUCTURE ABOVE WITH 5/8" TYPE 'X' GYP. BD. ON UTILITY ROOM SIDE FROM FLOOR TO STRUCTURE ABOVE (AT OFFICE, PLACE 5/8" MARINE GR. PLYWOOD OVER STUDS BEFORE GYP. BD.) . SEAL AIR TIGHT. INSTALL DENS-SHIELD FIREGUARD FROM FLOOR TO 3'-0" MIN. A.F.F. AND 5/8" WATER RESISTANT TYPE
- 2. 6" 25 GA. METAL STUDS AT 16" O.C. WITH 5/8" CEMENT BOARD FROM FLOOR TO 18" A.F.F. AND 5/8" TYPE 'X' WATER RESISTANT GYP. BD. FROM 18" A.F.F. TO ROOF DECK. SEE DETAIL
- . 3 5/8" 25 GA. METAL STUDS AT 16" O.C. FROM FLOOR TO BOTTOM OF COUNTER WITH 5/8" TYPE'X' GYP. BD. TO BOTTOM OF COUNTER ON ONE SIDE AND 5/8" CEMENT BOARD ON THE SERVING
- 4. LOW WALL WITH 1X WOOD CAP, TOP AT 4'-4" A.F.F., 3 5/8 25 GA. METAL STUDS AT 16 O.C. WITH 5/8" TYPE 'X' GYP. BD. ON CUSTOMER SIDE AND 5/8" CEMENT BOARD FROM FLOOR TO
- 5. LOW WALL WITH 1X WOOD CAP, TOP AT 4'-4" A.F.F., TO BE 6" 25 GA METAL STUDS AT 16" O.C.
- 6. $3\,5$ /8" $25\,$ GA. METAL STUDS AT $16_{ iny 2}\,$ O.C. WITH $\,5$ /8" CEMENT BOARD FROM FLOOR TO 3'-0" A.F.F.
- AND 5/8" TYPE 'X' WATER RESISTANT GYP. BD. ABOVE 3'-0" A.F.F. FINISH ALL WALL FACES WITH TILE. INSTALL SOFFIT WALL FROM 7'-2". WALL TO 3 5/8" 25 GA. METAL STUDS AT 16" O.C. FROM
- DESIGNATED HEIGHT TO STRUCTURE ABOVE WITH 5/8" TYPE 'X' GYP. BD. TO ROOF DECK ABOVE ON CUSTOMER SIDE AND 5/8" TYPE 'X' GYP. BD. TO 6" ABOVE CEILING AT

PARTITION NOTES

- 3" SOUND ATTENUATION BLANKETS FROM FLOOR TO 6" ABOVE CEILING (AT OFFICE, RESTROOMS)
- PROVIDE CONCEALED SUPPORT BLOCKING AT ALL TOILET ACCESSORIES, AND WALL MOUNTED LIGHT FIXTURES, FOOD SERVICE EQUIPMENT, AND SIMILARLOCATIONS AS REQUIRED FOR SOUND, STABLE INSTALLATION. FIELD VERIFY ALL LOCATIONS.
- AT ALL PARTITIONS THAT RUN FROM SLAB TO ROOF DECK, PROVIDE SLIP CONNECTION AT DECK TO ALLOW FOR DEFLECTION MOVEMENT IN ROOF STRUCTURE. REFER TO STRUCTURAL DRAWINGS FOR REQ'D BRACING & CONNECTIONS.
- . GC TO PROVIDE FIRESTOPPING AND FIRESAFING AS REQ'D AT ALL FLOOR, ROOF, AND WALL PENETRATIONS AS REQUIRED BY CODE AUTHORITIES.
- 5. PROVIDE 5/8" FIRE TREATED MARINE GRADE PLYWOOD ON ALL INTERIOR WALLS (KITCHEN/UTILITY ROOM FACE) AROUND OFFICE.

- FLOOR TO ROOF DECK OR BOTTOM OF GYP. BD. CEILING (WHERE APPLICABLE)
- FLOOR TO 18" A.F.F. AND 5/8" FIRE TREATED, MARINE GRADE PLYWOOD FROM 18" A.F.F. TO ROOF DECK. ON OFFICE SIDE, 5/8" TYPE 'X' DENS SHIELD GYP. BD. TO 8'-0" A.F.F. AND 5/8" TYPE 'X' GYP. BD. TO ROOF DECK - FLOOR TO ROOF DECK. SOUND BATTS IN WALL CAVITY -
- 5/8" 25 GA. METAL STUDS AT 16" O.C. FROM FLOOR TO ROOF DECK WITH 5/8" CEMENT BOARD FROM FLOOR TO 18" A.F.F. AND 5/8" TYPE 'X' WATER RESISTANT GYP. BD. FROM 18" A.F.F. TO TOP OF WALL ON KITCHEN SIDE. ON POINT OF SERVICE SIDE, 5/8" TYPE 'X' MOISTURE RESISTANT GYP.
- . 3 5/8" 25 GA. METAL STUDS AT 16" O.C. TO ROOF DECK WITH 5/8" TYPE 'X' GYP. BD.ON ONE
- FROM FLOOR TO 18" A.F.F. AND 5/8" TYPE 'X' WATER RESISTANT GYP. BD. FROM 18" A.F.F. TO
- ABOVE ACOUSTICAL CEILING (AT RESTROOMS, TO BOTTOM OF GYP. BD. CEILING.)
- TOP OF OAK WALL CAP AT 5'-0"
- TOP OF OAK WALL CAP AT 4'-4"
- GYP. BD. FROM FLOOR TO STRUCTURE ABOVE AND SEAL AIR TIGHT.
- 'X' GYP. BD. FROM 3'-0" TO STRUCTURE ABOVE. SEAL AIR TIGHT.
- SIDE (SEE COUNTER SECTION) . NOTE: TOP OF FINISHED WALL TO BE 2'-10" MAX.
- 18" AND 5/8" TYPE 'X' GYP. BD. ABOVE ON SERVING SIDE.
- WITH 5/8" TYPE 'X' GYP. BD. ON EACH SIDE.
- "SHAKE/TAKE-OUT" SIDE. BRACE WALL WITH DIAGONAL 2X4'S AT 6'-0" O.C.

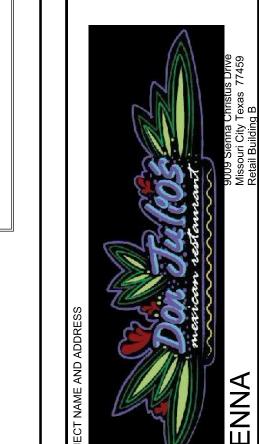

DO NOT SCALE DRAWINGS CONTRACTOR TO VERIFY ALL EXISTING CONDITIONS AND DIMENSIONS-NOTIFY DESIGNER OF ANY DESCREPANCIES PRIOR TO BEGINNING CONSTRUCTION

PERMIT REVIEW 09/21/

PROJECT NUMBER FCF5625

AS NOTED METAL STUD FRAMING

SHEET NUMBER

ISSUE DATE - 5-26-2010 PRINT DATE - 9-21-2010

THIS PLAN IS COPYRIGHT PROTECTED AND THE SOL PROPERTY OF GENE GILES ANY UNAUTHORIZED COPIES OR DISTRIBUTION IS A VIOLATION OF FEDERAL COPYRIGHT LAW AND SUBJECT TO PROSECUTION UNDER THE GUIDELINES OF THE FEDERAL COPYRIGHT ACT